


<b>Proj.-Nr.</b>	<b>3</b>	<b>9</b>	<b>1</b>	<b>8</b>	<b>6</b>	<b>1</b>	<b>Gegenstand:</b> Aufmaß von Bohrpunkten	<b>Arbeitsbericht</b>					
<b>Proj.Bezeichnung:</b> Mönlas B85,St2166 Mönlas							<b>Grundlagen:</b> DFK, B85 Mönlas_Lageplan_neu_05.09.2019_Bohrungen und Sondierungen.pdf	<b>Nr.:</b>	<b>0</b>	<b>2</b>	<b>Index</b>		
							<b>Datum:</b>	0	2	1	2	1	9

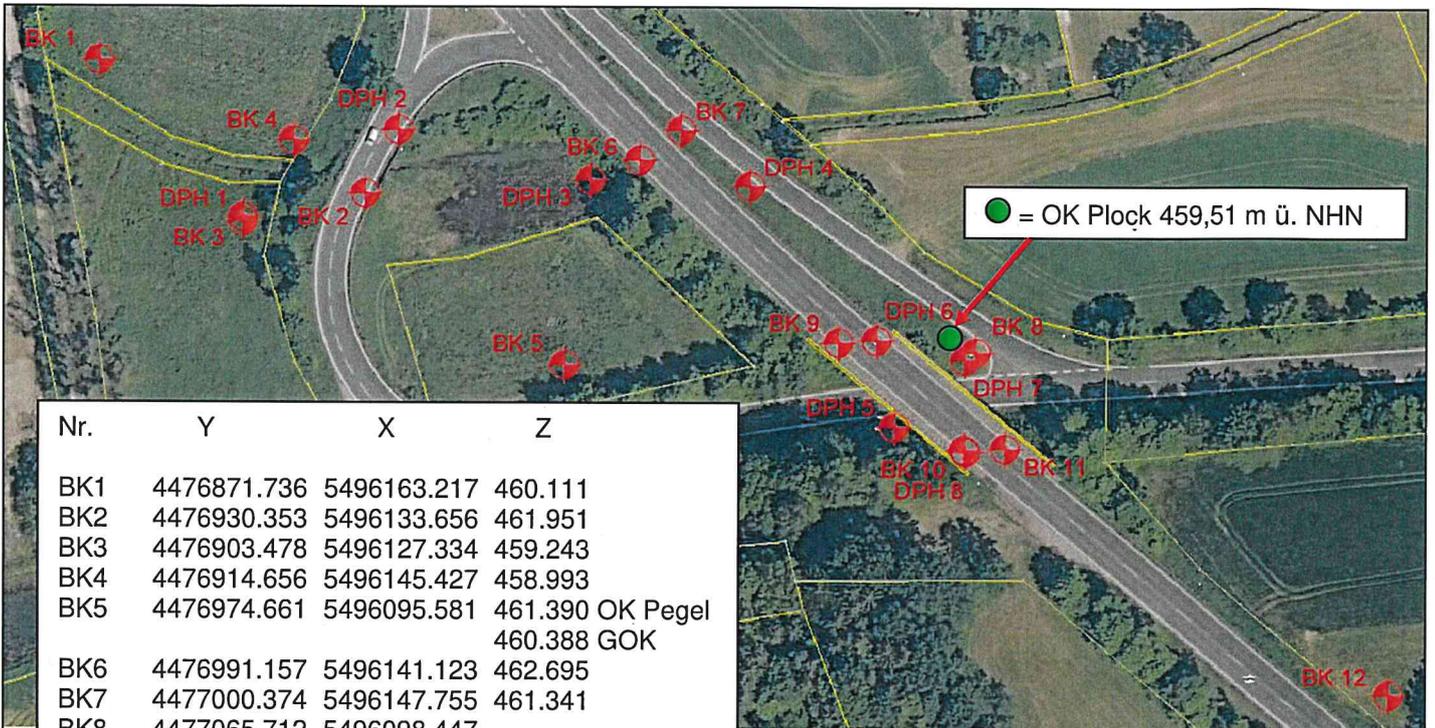

Nr.	Y	X	Z
BK1	4476871.736	5496163.217	460.111
BK2	4476930.353	5496133.656	461.951
BK3	4476903.478	5496127.334	459.243
BK4	4476914.656	5496145.427	458.993
BK5	4476974.661	5496095.581	461.390 OK Pegel 460.388 GOK
BK6	4476991.157	5496141.123	462.695
BK7	4477000.374	5496147.755	461.341
BK8	4477065.712	5496098.447	458.856 GOK
BK9	4477035.387	5496100.607	464.566
BK10	4477063.177	5496076.817	466.010
BK11	4477072.288	5496077.053	466.149
BK12	4477157.862	5496022.229	469.763
DPH1	4476903.594	5496128.454	459.244
DPH2	4476937.746	5496147.818	461.967
DPH3	4476980.299	5496136.696	458.728
DPH4	4477015.618	5496135.373	460.756
DPH5	4477047.817	5496081.855	458.660
DPH6	4477043.802	5496101.115	464.591
DPH7	4477063.396	5496096.828	458.827
DPH8	4477063.540	5496076.356	466.030

(Angaben im amtl. G.K.-System / DHHN2016)


Lage und Höhe der abgesteckten Punkte gelten nur zum Zeitpunkt der Einmessung / Übergabe !

<b>Mitarbeiter:</b> J. Weimar	<b>Bauherr:</b>	Die Übergabe vorstehender Leistungen wird hiermit bestätigt: Regensburg, den 02.12.2019	
<b>Ausrüstung:</b> TS 30 GPS CS 10 DNA 03	<b>Auftraggeber (Bauleiter):</b> Fa. Terrasond Herr Dittrich Auftrag vom: 04.09.2019	Für den Auftraggeber:  Unterschrift	Angerer & Weimar GmbH:   Unterschrift

Terrasond GmbH & Co. KG	Projekt: B85, St 2166 bei Mönlas
St.-Ulrich-Straße 12-16	Projektnr.: 2019-1001
89312 Günzburg-Deffingen	Koordinaten : 4476871.74 / 5496163.22
Tel.: 0 82 21/9 06-0 / Fax:-40	Maßstab : 1: 100

BK 1


Ansatzpunkt: 460.11 mNN

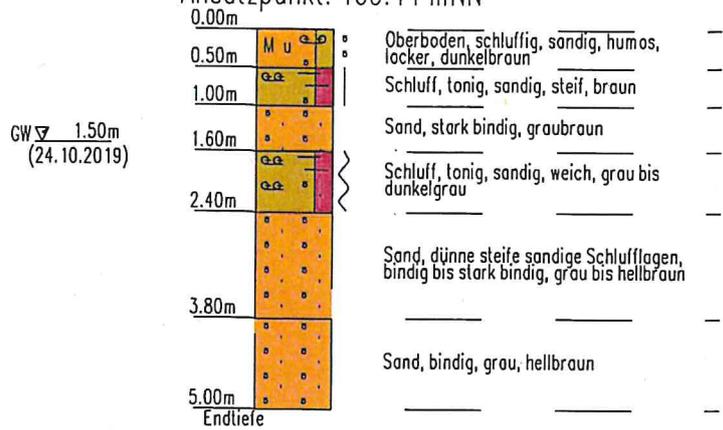

Terrasond GmbH & Co. KG	Projekt: B85, St 2166 bei Mönlas
St.-Ulrich-Straße 12-16	Projektnr.: 2019-1001
89312 Günzburg-Deffingen	Koordinaten : 4476930.35 / 5496133.66
Tel.: 0 82 21/9 06-0 / Fax:-40	Maßstab : 1: 150

BK 2

Ansatzpunkt: 461.95 mNN

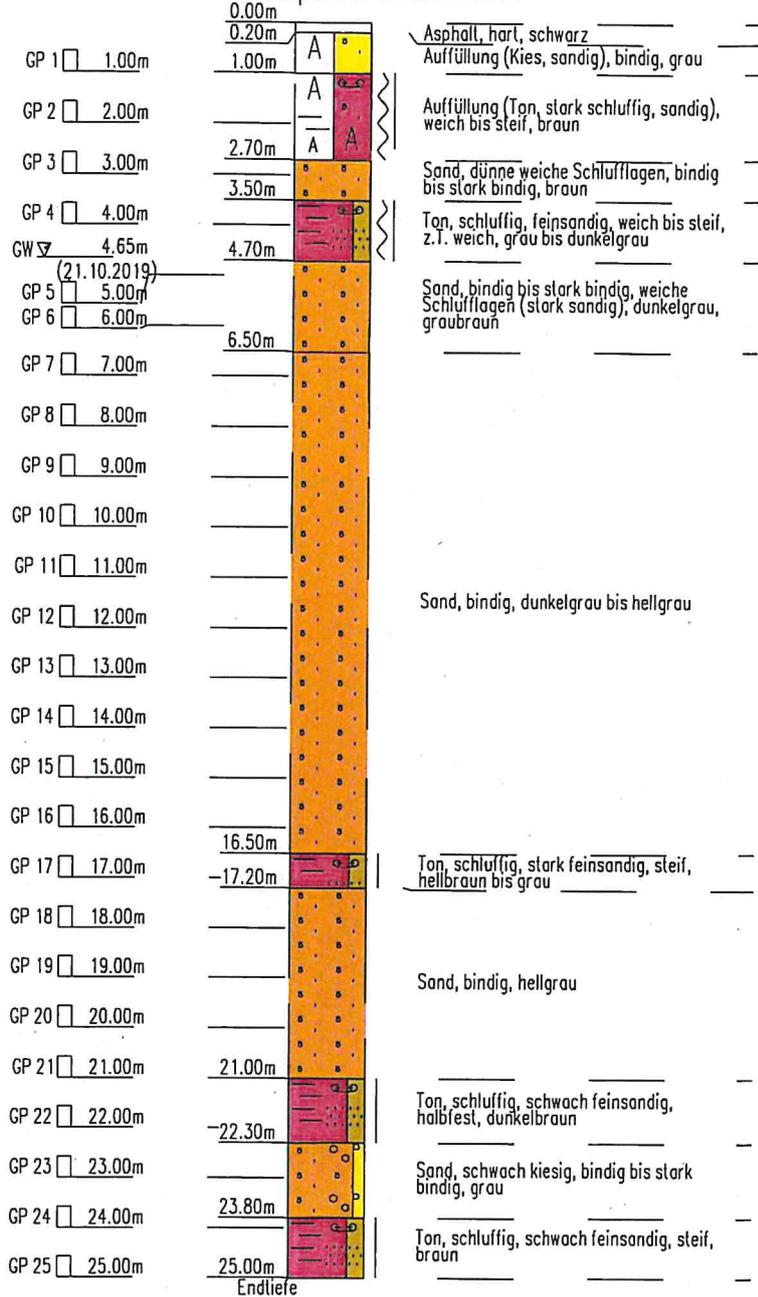


Endtiefe

Terrasond GmbH & Co. KG	Projekt: B85, St 2166 bei Mönlas
St.-Ulrich-Straße 12-16	Projektnr.: 2019-1001
89312 Günzburg-Deffingen	Koordinaten : 4476903.48 / 5496127.33
Tel.: 0 82 21/9 06-0 / Fax:-40	Maßstab : 1: 100

BK 3

Ansatzpunkt: 459.24 mNN

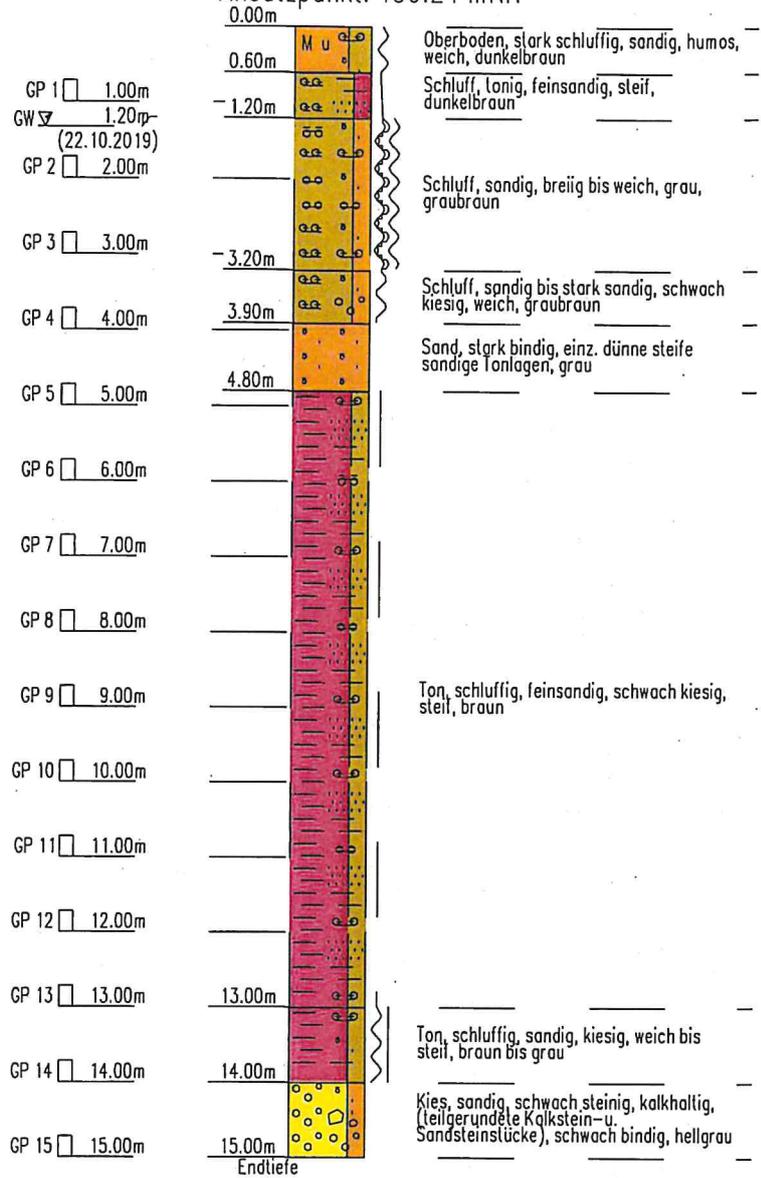


- GP 1 □ 1.00m
- GW ▽ 1.20m (22.10.2019)
- GP 2 □ 2.00m
- GP 3 □ 3.00m
- GP 4 □ 4.00m
- GP 5 □ 5.00m
- GP 6 □ 6.00m
- GP 7 □ 7.00m
- GP 8 □ 8.00m
- GP 9 □ 9.00m
- GP 10 □ 10.00m
- GP 11 □ 11.00m
- GP 12 □ 12.00m
- GP 13 □ 13.00m
- GP 14 □ 14.00m
- GP 15 □ 15.00m

Terrasond GmbH & Co. KG	Projekt: B85, St 2166 bei Mönlas
St.-Ulrich-Straße 12-16	Projektnr.: 2019-1001
89312 Günzburg-Deffingen	Koordinaten : 4476914.66 / 5496145.43
Tel.: 0 82 21/9 06-0/ Fax:-40	Maßstab : 1: 100


BK 4

Ansatzpunkt: 458.99 mNN

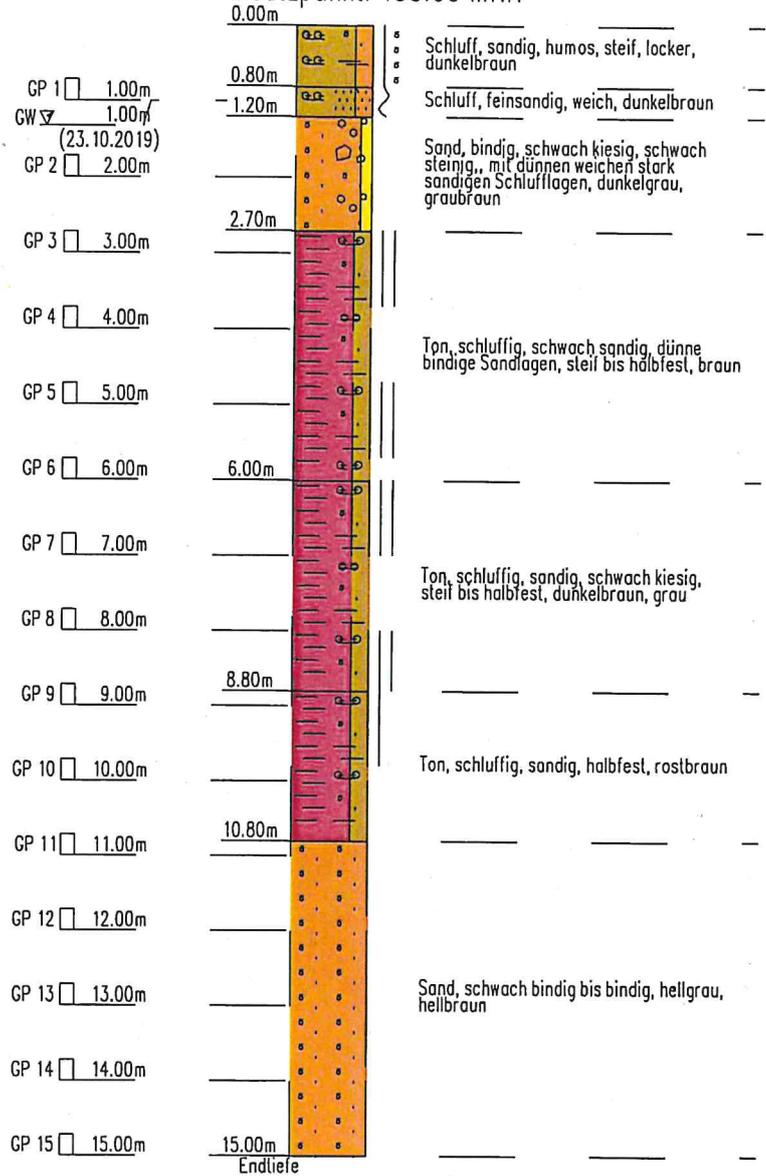


Terrasond GmbH & Co. KG	Projekt: B85, St 2166 bei Mönlas
St.-Ulrich-Straße 12-16	Projektnr.: 2019-1001
89312 Günzburg-Deffingen	Koordinaten : 4476974.66 / 5496095.58
Tel.: 0 82 21/9 06-0/ Fax:-40	Maßstab : 1: 100 / 1: 20

BK 5  
 Ansatzpunkt: 460.39 mNN

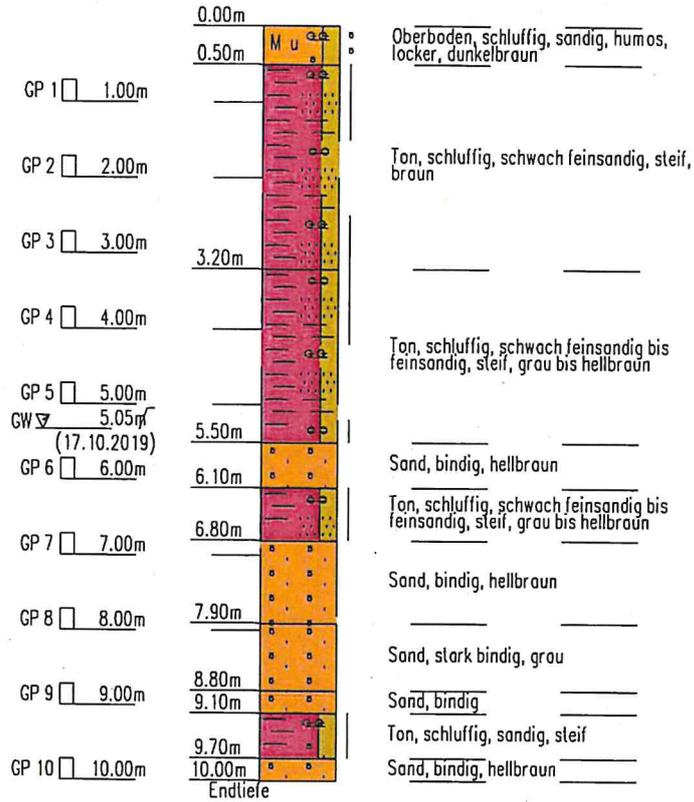


BK 5  
 OK 461.39

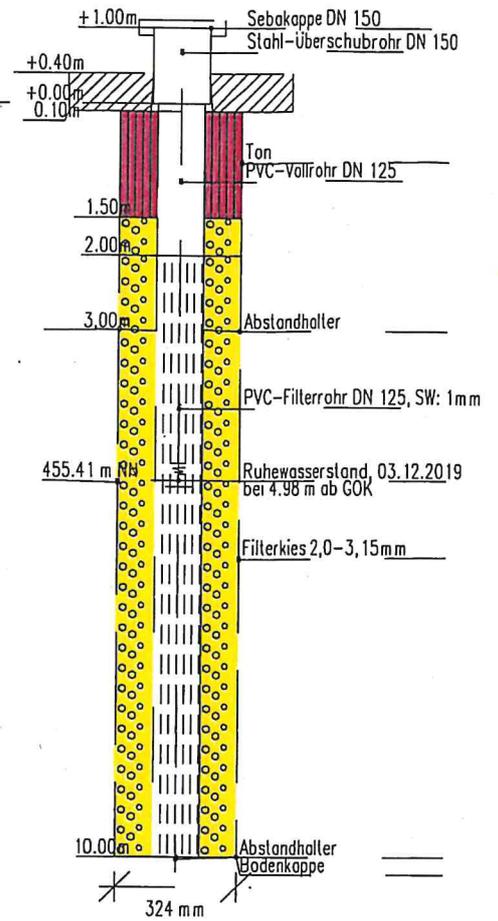

Terrasond GmbH & Co. KG	Projekt: B85, St 2166 bei Mönlas
St.-Ulrich-Straße 12-16	Projektnr.: 2019-1001
89312 Günzburg-Deffingen	Koordinaten : 4476991.16 / 5496141.12
Tel.: 0 82 21/9 06-0/ Fax:-40	Maßstab : 1:150

BK 6


Ansatzpunkt: 462.70 mNN

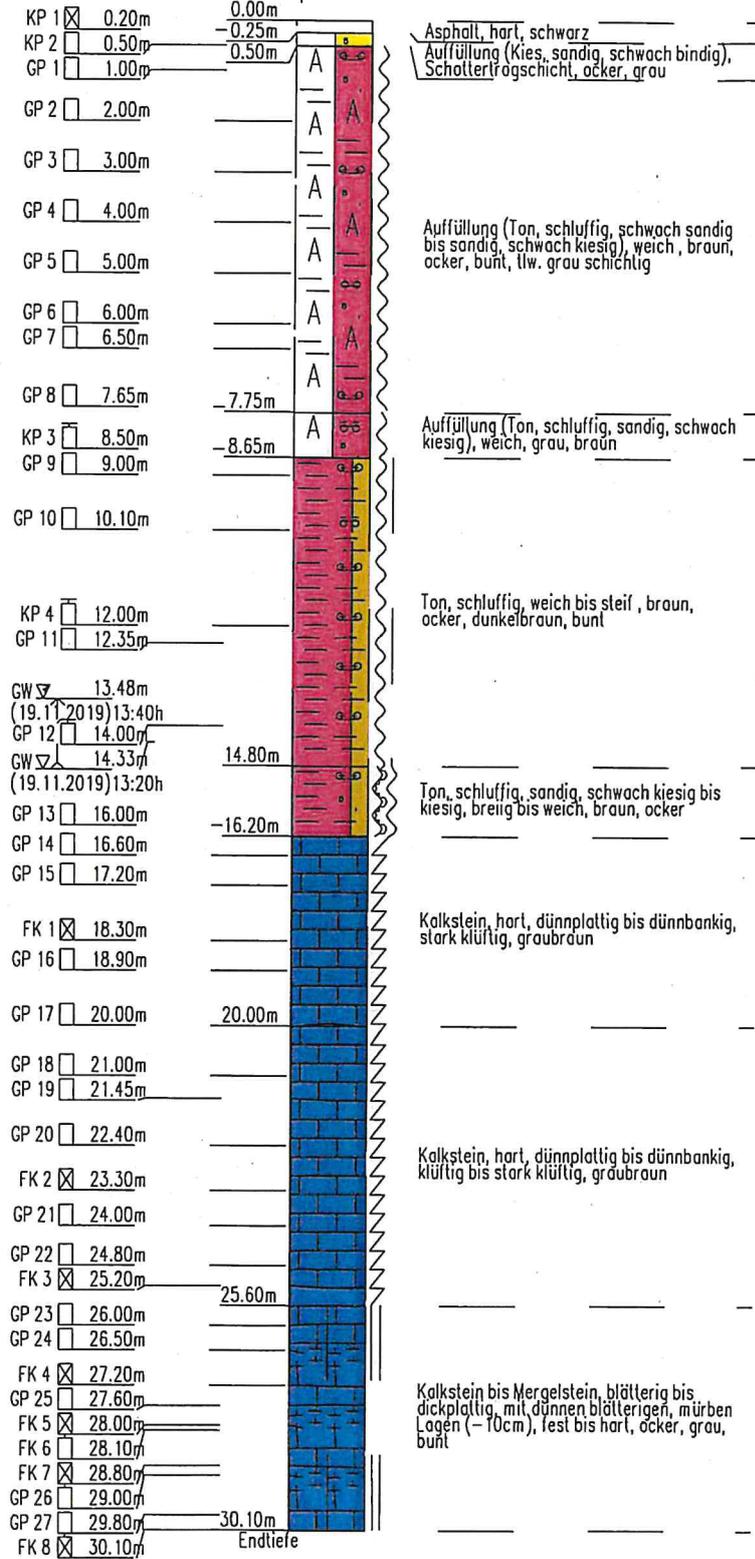


Terrasond GmbH & Co. KG	Projekt: B85, St 2166 bei Mönlas
St.-Ulrich-Straße 12-16	Projektnr.: 2019-1001
89312 Günzburg-Deffingen	Koordinaten : 4477000.37 / 5496147.76
Tel.: 0 82 21/9 06-0/ Fax:-40	Maßstab : 1: 150

BK 7

Ansatzpunkt: 461.34 mNN

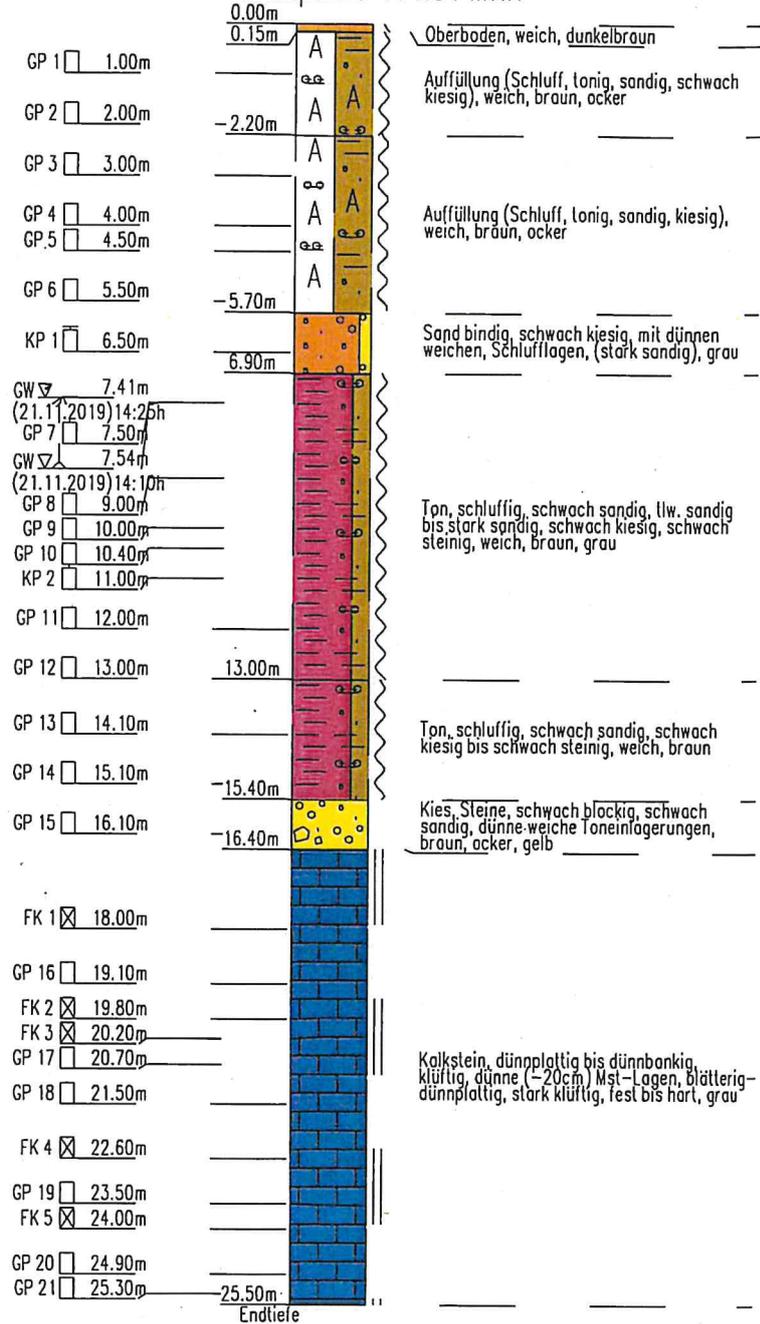


Terrasond GmbH & Co. KG	Projekt: B85, St 2166 bei Mönlas
St.-Ulrich-Straße 12-16	Projektnr.: 2019-1001
89312 Günzburg-Deffingen	Koordinaten : 4477065.71 / 5496098.45
Tel.: 0 82 21/9 06-0/ Fax:-40	Maßstab : 1: 150 / 1: 20

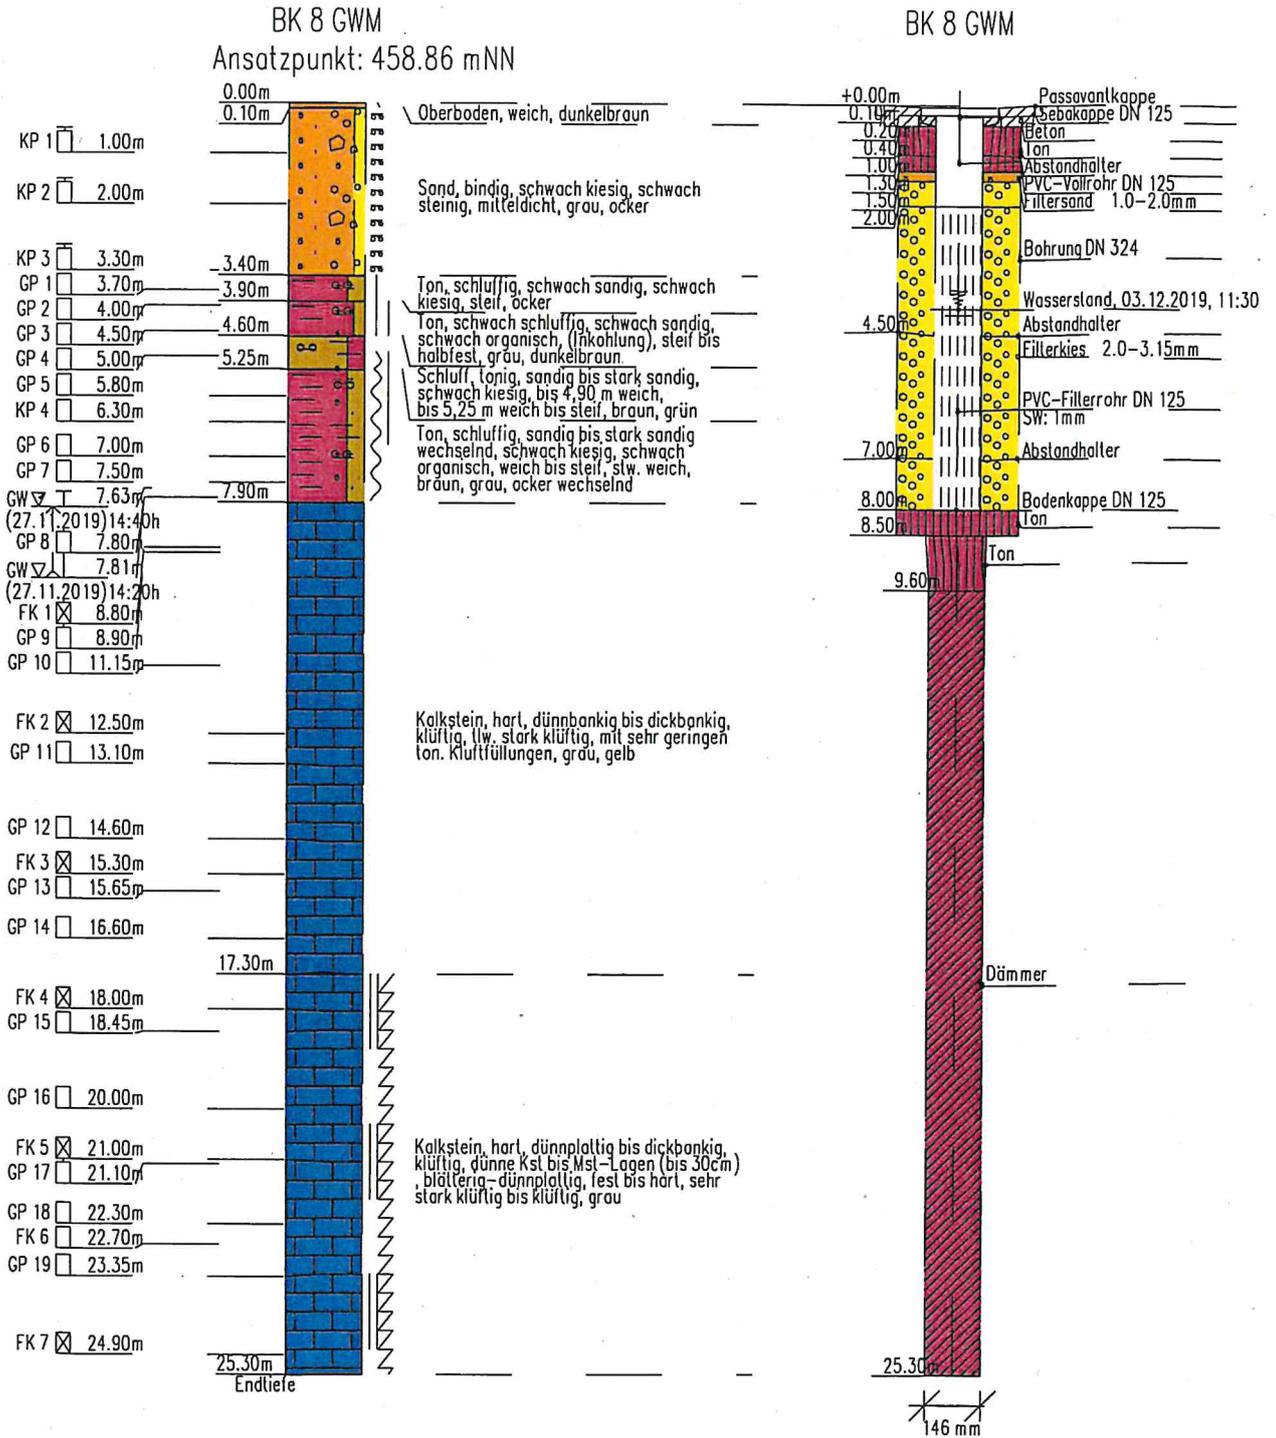

Terrasond GmbH & Co. KG	Projekt: B85, St 2166 bei Mönlas
St.-Ulrich-Straße 12-16	Projektnr.: 2019-1001
89312 Günzburg-Deffingen	Koordinaten : 4477035.39 / 5496100.61
Tel.: 0 82 21/9 06-0/ Fax:-40	Maßstab : 1:150

BK 9

Ansatzpunkt: 464.57 mNN

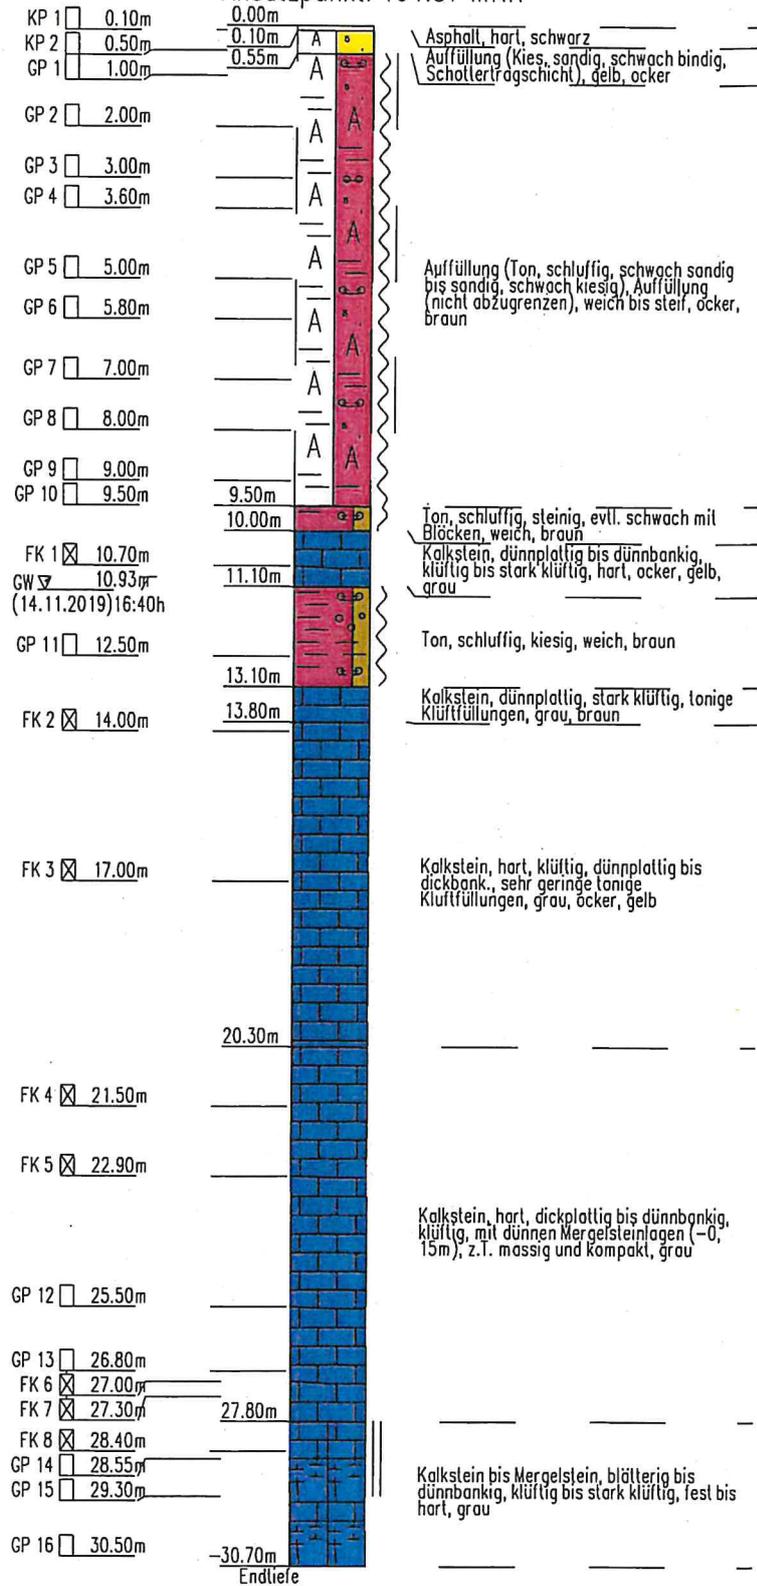


Terrasond GmbH & Co. KG	Projekt: B85, St 2166 bei Mönlas
St.-Ulrich-Straße 12-16	Projektnr.: 2019-1001
89312 Günzburg-Deffingen	Koordinaten : 4477063.18 / 5496076.82
Tel.: 0 82 21/9 06-0 / Fax:-40	Maßstab : 1: 150

BK 10  
 Ansatzpunkt: 466.01 mNN

- KP 1  0.15m
- KP 2  0.50m
- GP 1  1.00m
- GP 2  2.00m
- GP 3  3.00m
- GP 4  4.00m
- GP 5  5.00m
- GP 6  6.00m
- GP 7  7.00m
- GP 8  8.00m
- GP 9  9.00m
- KP 4  9.40m
- GP 10  10.10m
- GP 11  11.00m
- GP 12  11.50m
- KP 3  12.00m

- FK 1  13.80m
- GW  13.91m  
(13.11.2019) 14:10h
- FK 2  15.30m
- FK 3  16.60m
- FK 4  18.70m
- FK 5  21.60m
- FK 6  23.95m

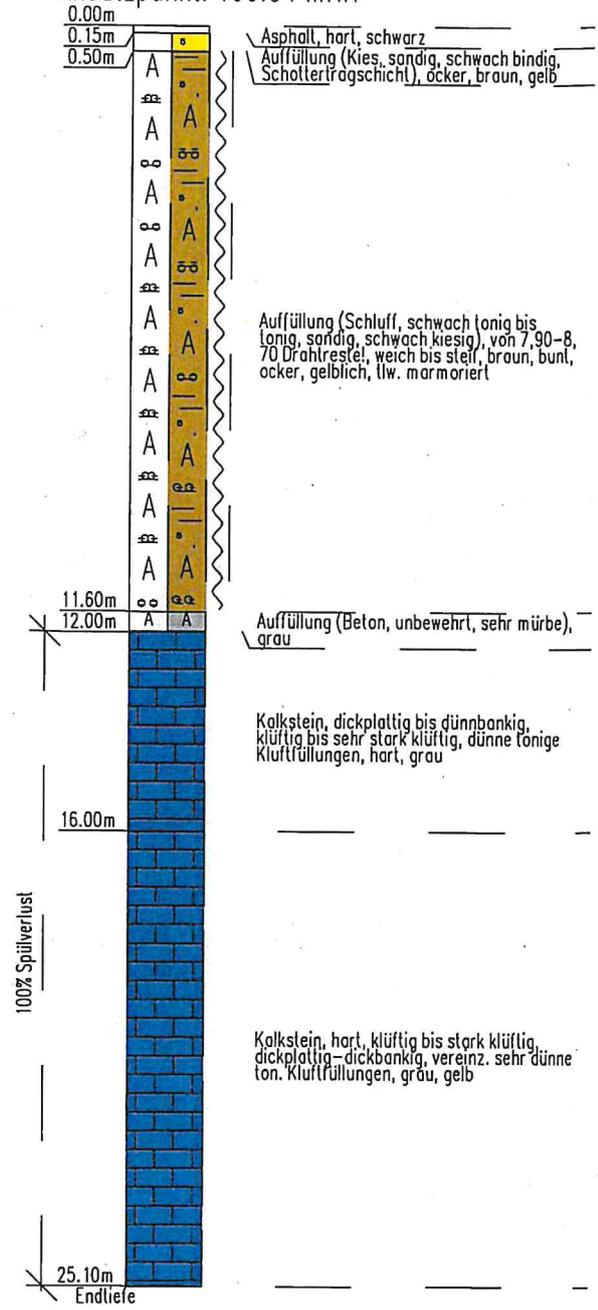


Terrasond GmbH & Co. KG	Projekt: B85, St 2166 bei Mönlas
St.-Ulrich-Straße 12-16	Projektnr.: 2019-1001
89312 Günzburg-Deffingen	Koordinaten : 4477072.29 / 5496077.05
Tel.: 0 82 21/9 06-0/ Fax:-40	Maßstab : 1: 150


BK 11

Ansatzpunkt: 466.15 mNN


- KP 1 □ 0.15m
- KP 2 □ 0.50m
- GP 1 □ 1.00m
- GP 2 □ 1.60m
- GP 3 □ 2.00m
- GP 4 □ 2.50m
- GP 5 □ 3.20m
- GP 6 □ 4.10m
- GP 7 □ 5.10m
- GP 8 □ 6.10m
- GP 9 □ 7.00m
- GP 10 □ 8.00m
- GP 11 □ 9.00m
- GP 12 □ 10.00m
- GP 13 □ 10.90m
- GP 14 □ 11.60m
- GP 15 □ 12.40m
- GP 16 □ 13.50m
- GW ▽ 14.84m  
(05.11.2019) 17:05h
- GP 17 □ 15.00m
- GW ▽ 15.07m  
(05.11.2019) 16:45h
- GP 18 □ 16.00m
- FK 1 ☒ 17.50m
- FK 2 ☒ 18.70m
- FK 3 ☒ 20.30m
- FK 4 ☒ 22.90m
- FK 5 ☒ 26.60m
- FK 6 ☒ 29.80m

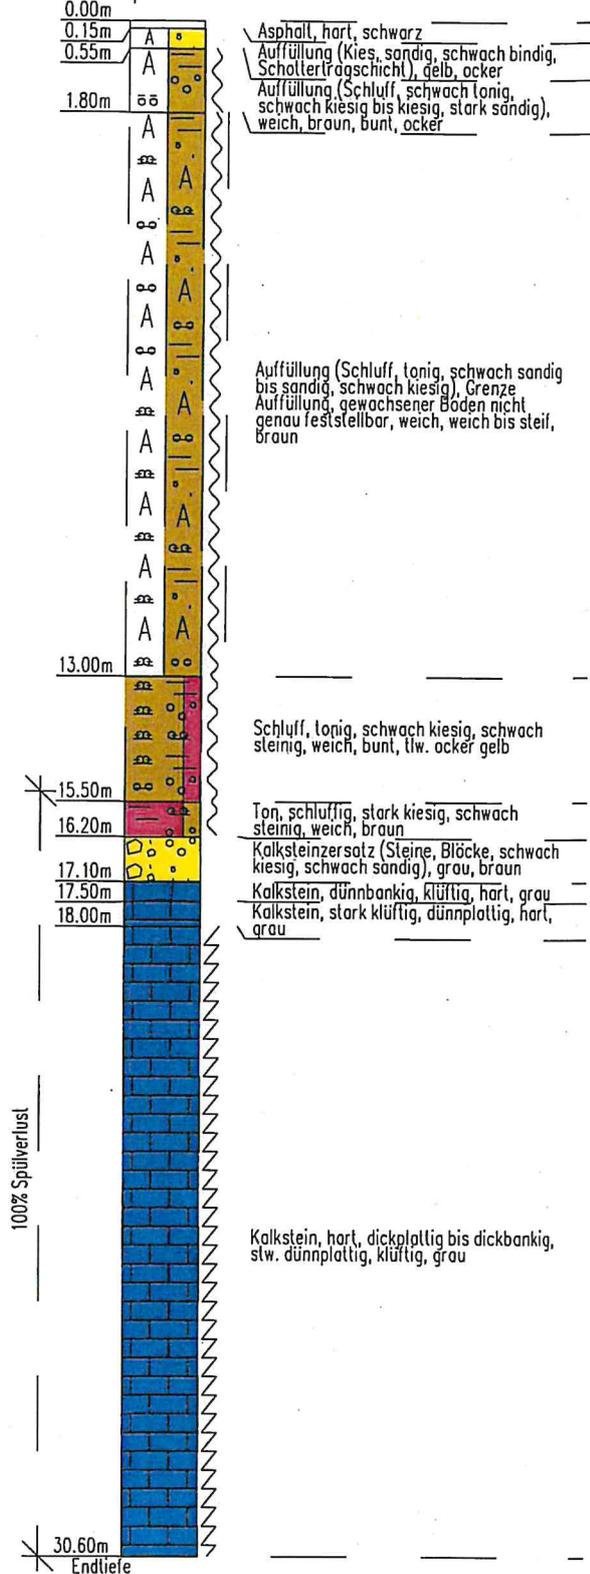

Terrasond GmbH & Co. KG	Projekt: B85, St 2166 bei Mönlas
St.-Ulrich-Straße 12-16	Projektnr.: 2019-1001
89312 Günzburg-Deffingen	Koordinaten : 4477157.86 / 5496022.23
Tel.: 0 82 21/9 06-0 / Fax:-40	Maßstab : 1: 100

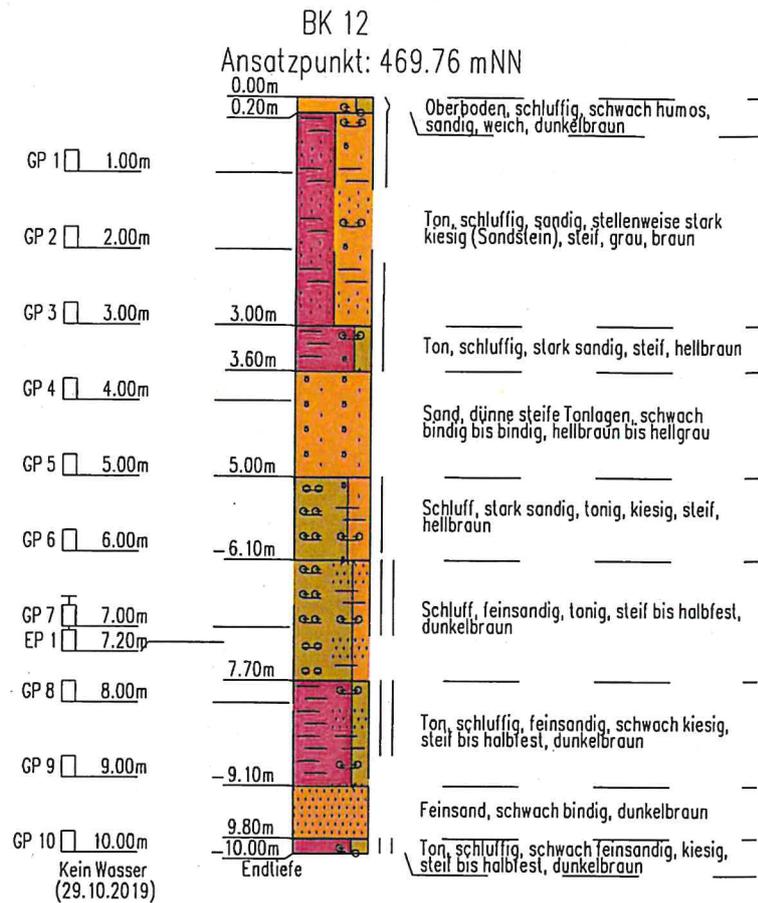


Tiefe	No	Tiefe	No	Tiefe	No
0.10	1	6.10	10	12.10	37
0.20	1	6.20	11	12.20	39
0.30	1	6.30	10	12.30	39
0.40	1	6.40	12	12.40	42
0.50	1	6.50	14	12.50	38
0.60	1	6.60	16	12.60	37
0.70	1	6.70	15	12.70	37
0.80	1	6.80	16	12.80	37
0.90	0	6.90	20	12.90	37
1.00	1	7.00	21	13.00	36
1.10	0	7.10	19	13.10	35
1.20	0	7.20	19	13.20	32
1.30	0	7.30	20	13.30	34
1.40	1	7.40	23	13.40	35
1.50	0	7.50	26	13.50	30
1.60	0	7.60	29	13.60	28
1.70	1	7.70	28	13.70	30
1.80	1	7.80	30	13.80	27
1.90	0	7.90	31	13.90	26
2.00	0	8.00	32	14.00	23
2.10	0	8.10	33	14.10	22
2.20	0	8.20	34	14.20	20
2.30	2	8.30	34	14.30	19
2.40	1		34	14.40	18
2.50	1	8.50	36	14.50	19
2.60	1	8.60	36	14.60	18
2.70	2	8.70	37	14.70	18
2.80	3	8.80	35	14.80	25
2.90	2		35	14.90	31
3.00	1	9.00	35	15.00	25
3.10	5	9.10	36		
3.20	7	9.20	36		
3.30	2	9.30	36		
3.40	6	9.40	35		
3.50	6	9.50	32		
3.60	11	9.60	32		
3.70	15	9.70	32		
3.80	10	9.80	34		
3.90	13	9.90	33		
4.00	9	10.00	33		
4.10	9	10.10	36		
4.20	12	10.20	33		
4.30	7	10.30	33		
4.40	6	10.40	37		
4.50	9	10.50	39		
4.60	10	10.60	37		
4.70	8	10.70	41		
4.80	6	10.80	40		
4.90	4	10.90	39		
5.00	5	11.00	36		
5.10	4	11.10	35		
5.20	6	11.20	36		
5.30	3	11.30	38		
5.40	3	11.40	37		
5.50	4	11.50	39		
5.60	3	11.60	38		
5.70	3	11.70	38		
5.80	5	11.80	44		
5.90	6	11.90	45		
6.00	8	12.00	41		

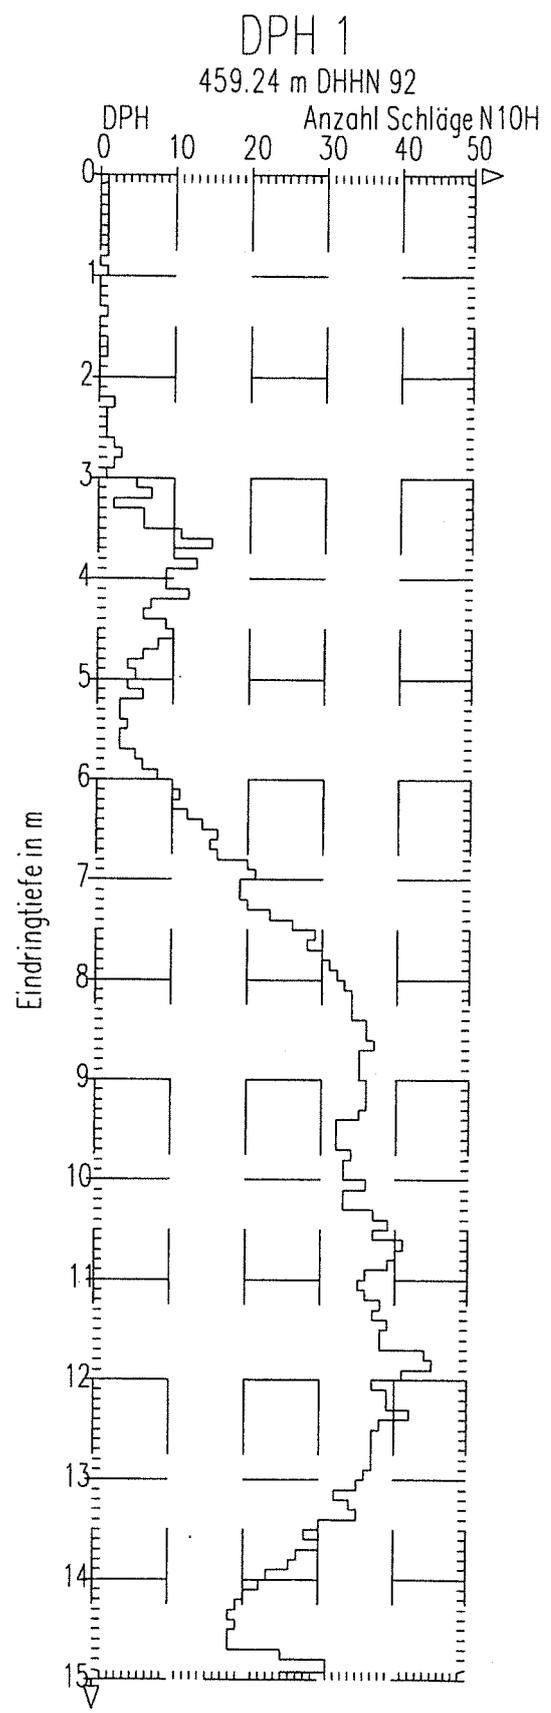


Tiefe	No	Tiefe	No
0.10	0	6.10	9
0.20	0	6.20	4
0.30	0	6.30	8
0.40	0	6.40	6
0.50	0	6.50	4
0.60	0	6.60	6
0.70	0	6.70	9
0.80	0	6.80	8
0.90	0	6.90	5
1.00	0	7.00	4
1.10	0	7.10	8
1.20	0	7.20	8
1.30	0	7.30	8
1.40	0	7.40	8
1.50	0	7.50	7
1.60	0	7.60	6
1.70	0	7.70	7
1.80	0	7.80	6
1.90	0	7.90	7
2.00	0	8.00	9
2.10	1	8.10	5
2.20	1	8.20	5
2.30	2	8.30	5
2.40	1	8.40	5
2.50	1	8.50	5
2.60	1	8.60	5
2.70	0	8.70	5
2.80	1	8.80	4
2.90	1	8.90	5
3.00	1	9.00	11
3.10	0	9.10	21
3.20	1	9.20	29
3.30	1	9.30	60
3.40	1	9.40	100
3.50	1		
3.60	1		
3.70	1		
3.80	2		
3.90	2		
4.00	2		
4.10	1		
4.20	2		
4.30	1		
4.40	2		
4.50	1		
4.60	2		
4.70	1		
4.80	1		
4.90	2		
5.00	4		
5.10	7		
5.20	6		
5.30	7		
5.40	5		
5.50	4		
5.60	3		
5.70	3		
5.80	3		
5.90	7		
6.00	9		


Vorgebo

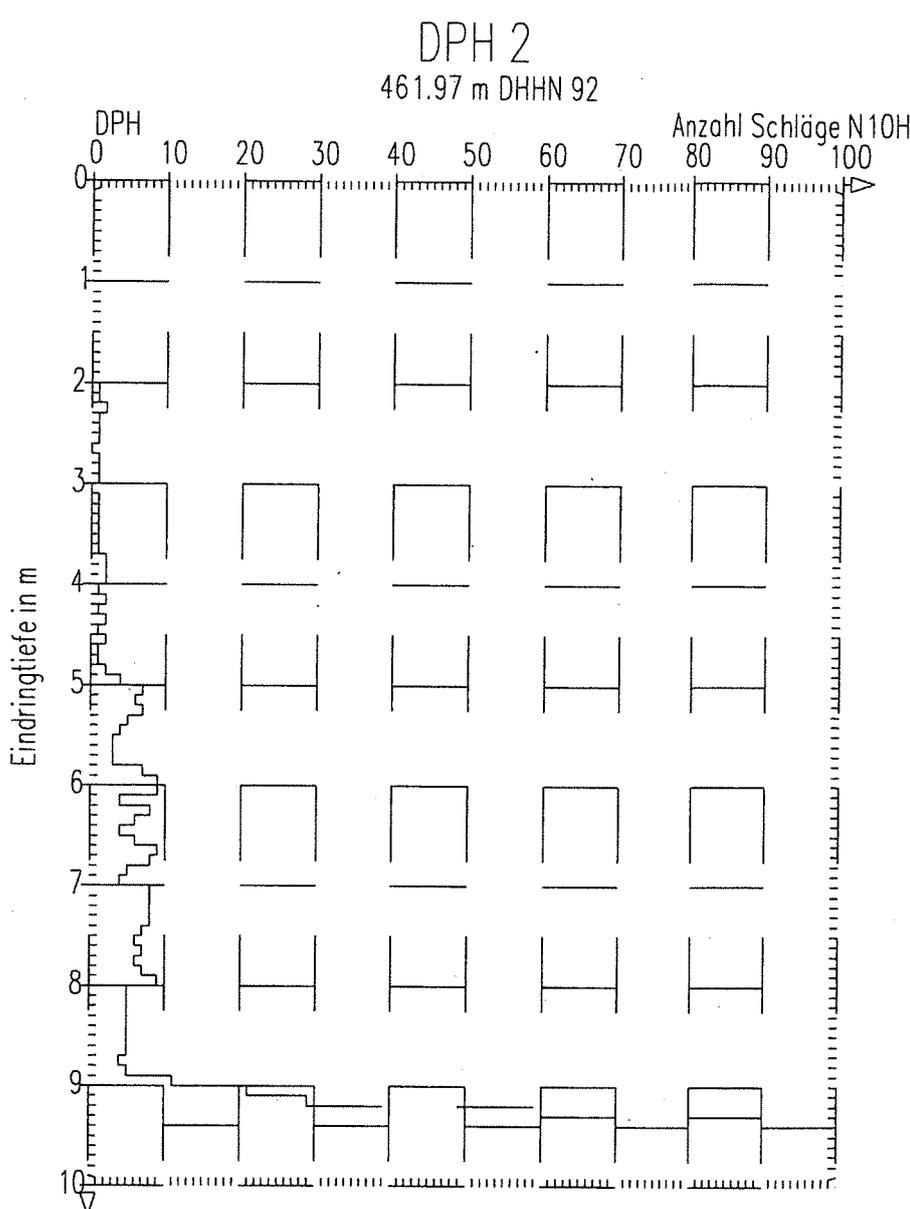


Tiefe	N <sub>10</sub>	Tiefe	N <sub>10</sub>
0.10	1	6.10	21
0.20	1	6.20	31
0.30	1	6.30	32
0.40	2	6.40	30
0.50	1	6.50	27
0.60	1	6.60	43
0.70	1	6.70	34
0.80	2	6.80	20
0.90	2	6.90	28
1.00	1	7.00	26
1.10	1	7.10	22
1.20	1	7.20	24
1.30	1	7.30	25
1.40	2	7.40	16
1.50	1	7.50	18
1.60	3	7.60	20
1.70	1	7.70	27
1.80	2	7.80	30
1.90	2	7.90	30
2.00	1	8.00	27
2.10	1	8.10	24
2.20	1	8.20	14
2.30	2	8.30	11
2.40	2	8.40	9
2.50	1	8.50	8
2.60	2	8.60	13
2.70	2	8.70	8
2.80	3	8.80	4
2.90	3	8.90	5
3.00	4	9.00	8
3.10	3	9.10	9
3.20	3	9.20	16
3.30	4	9.30	7
3.40	4	9.40	9
3.50	5	9.50	9
3.60	9	9.60	9
3.70	8	9.70	14
3.80	13	9.80	28
3.90	11	9.90	36
4.00	9	10.00	24
4.10	5	10.10	26
4.20	7	10.20	24
4.30	6	10.30	21
4.40	8	10.40	18
4.50	9	10.50	17
4.60	13	10.60	16
4.70	15	10.70	14
4.80	16	10.80	14
4.90	14	10.90	11
5.00	14	11.00	10
5.10	16	11.10	12
5.20	19	11.20	8
5.30	19	11.30	8
5.40	20	11.40	5
5.50	21	11.50	6
5.60	23	11.60	5
5.70	25	11.70	32
5.80	21	11.80	37
5.90	23	11.90	76
6.00	28	12.00	100

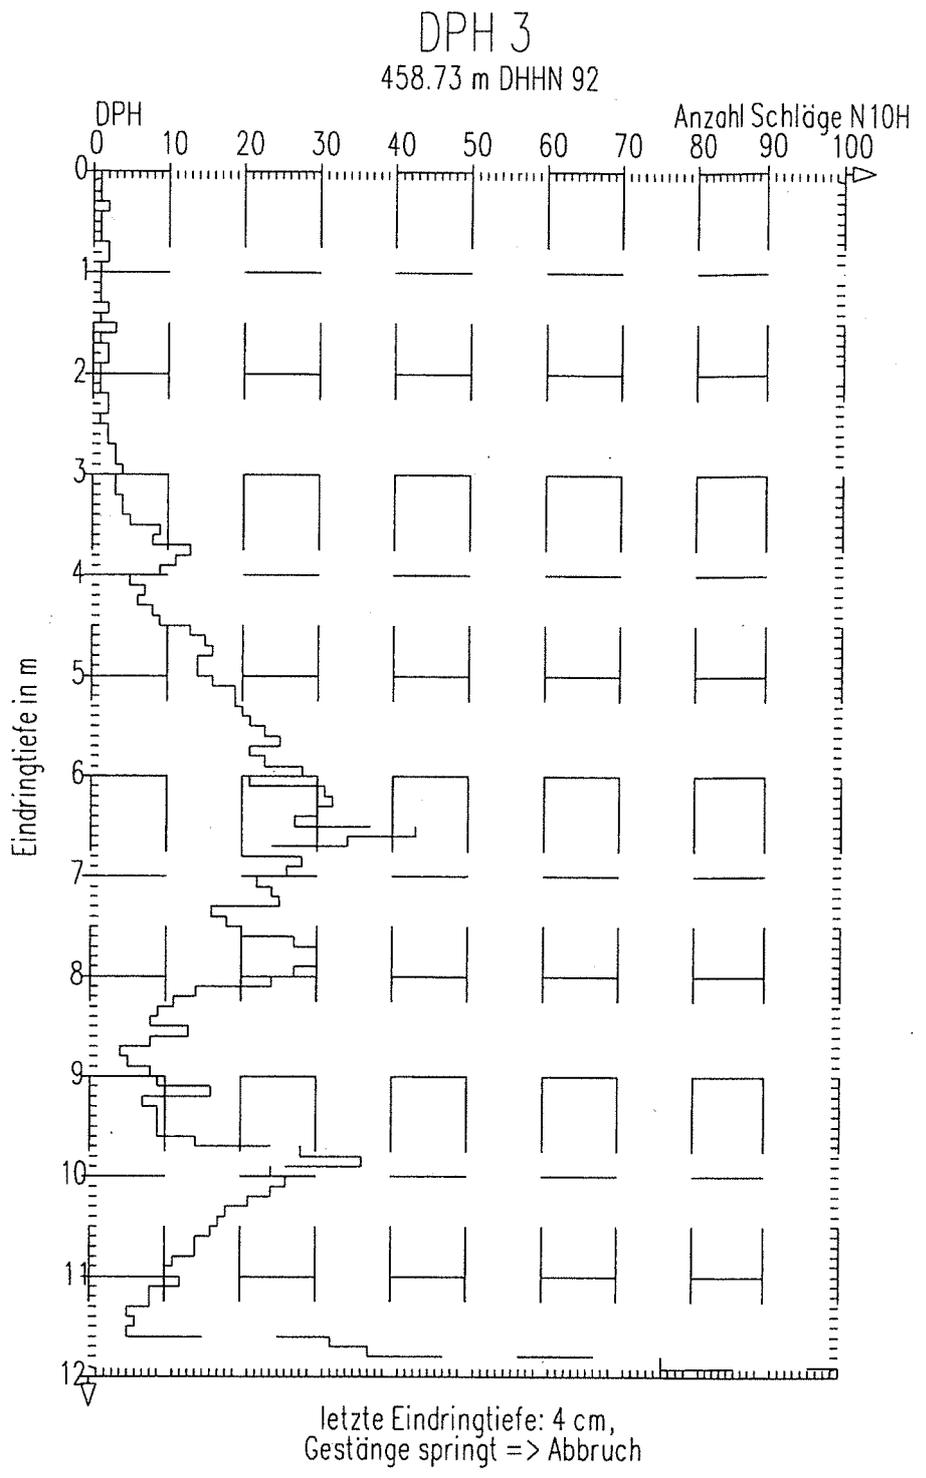

Tiefe	No	Tiefe	No
0.10	1	6.10	10
0.20	1	6.20	25
0.30	3	6.30	19
0.40	1	6.40	11
0.50	1	6.50	9
0.60	6	6.60	8
0.70	1	6.70	8
0.80	4	6.80	8
0.90	2	6.90	7
1.00	1	7.00	8
1.10	0	7.10	8
1.20	1	7.20	8
1.30	0	7.30	11
1.40	0	7.40	9
1.50	2	7.50	10
1.60	1	7.60	9
1.70	1	7.70	9
1.80	1	7.80	6
1.90	1	7.90	8
2.00	1	8.00	9
2.10	1	8.10	6
2.20	1	8.20	8
2.30	2	8.30	7
2.40	2	8.40	7
2.50	1	8.50	9
2.60	2	8.60	12
2.70	2	8.70	12
2.80	3	8.80	16
2.90	3	8.90	13
3.00	3	9.00	14
3.10	3	9.10	13
3.20	2	9.20	16
3.30	2	9.30	100
3.40	2		
3.50	2		
3.60	2		
3.70	2		
3.80	2		
3.90	3		
4.00	2		
4.10	3		
4.20	4		
4.30	3		
4.40	5		
4.50	4		
4.60	4		
4.70	5		
4.80	5		
4.90	5		
5.00	5		
5.10	6		
5.20	5		
5.30	6		
5.40	6		
5.50	5		
5.60	6		
5.70	13		
5.80	7		
5.90	9		
6.00	9		

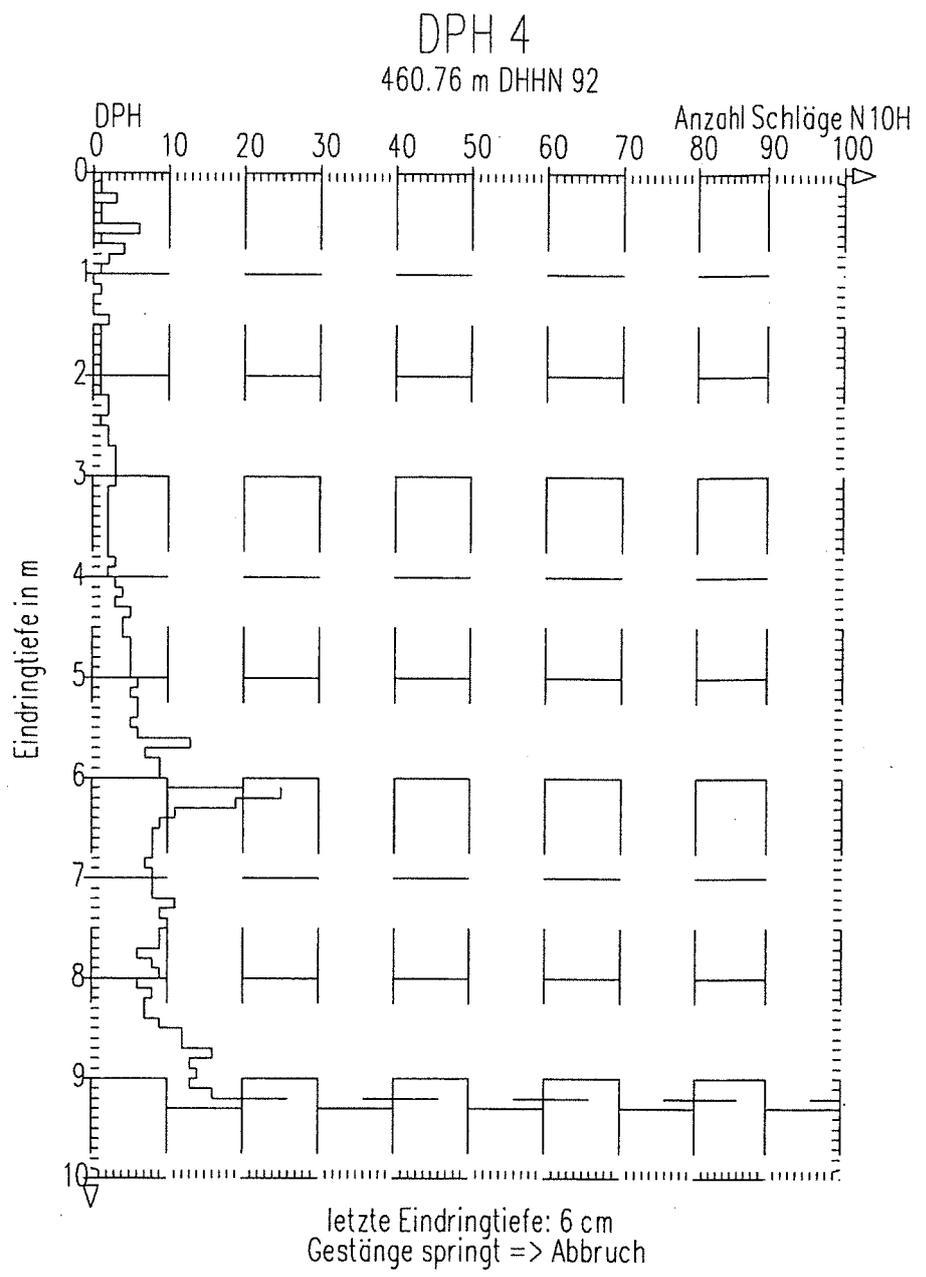


Tiefe	No	Tiefe	No
0.10	1	6.10	8
0.20	1	6.20	8
0.30	1	6.30	11
0.40	2	6.40	8
0.50	1	6.50	7
0.60	1	6.60	9
0.70	1	6.70	9
0.80	1	6.80	8
0.90	1	6.90	5
1.00	1	7.00	6
1.10	2	7.10	8
1.20	2	7.20	7
1.30	2	7.30	11
1.40	2	7.40	13
1.50	3	7.50	14
1.60	4	7.60	10
1.70	4	7.70	14
1.80	4	7.80	10
1.90	3	7.90	22
2.00	4	8.00	12
2.10	3	8.10	24
2.20	3	8.20	48
2.30	4	8.30	25
2.40	5	8.40	20
2.50	4	8.50	21
2.60	3	8.60	14
2.70	4	8.70	12
2.80	3	8.80	9
2.90	3	8.90	5
3.00	2	9.00	7
3.10	2	9.10	11
3.20	1	9.20	11
3.30	1	9.30	11
3.40	1	9.40	9
3.50	2	9.50	11
3.60	15	9.60	11
3.70	3	9.70	11
3.80	12	9.80	100
3.90	16		
4.00	7		
4.10	18		
4.20	18		
4.30	10		
4.40	10		
4.50	5		
4.60	6		
4.70	7		
4.80	6		
4.90	5		
5.00	4		
5.10	4		
5.20	5		
5.30	6		
5.40	4		
5.50	9		
5.60	20		
5.70	9		
5.80	12		
5.90	15		
6.00	10		

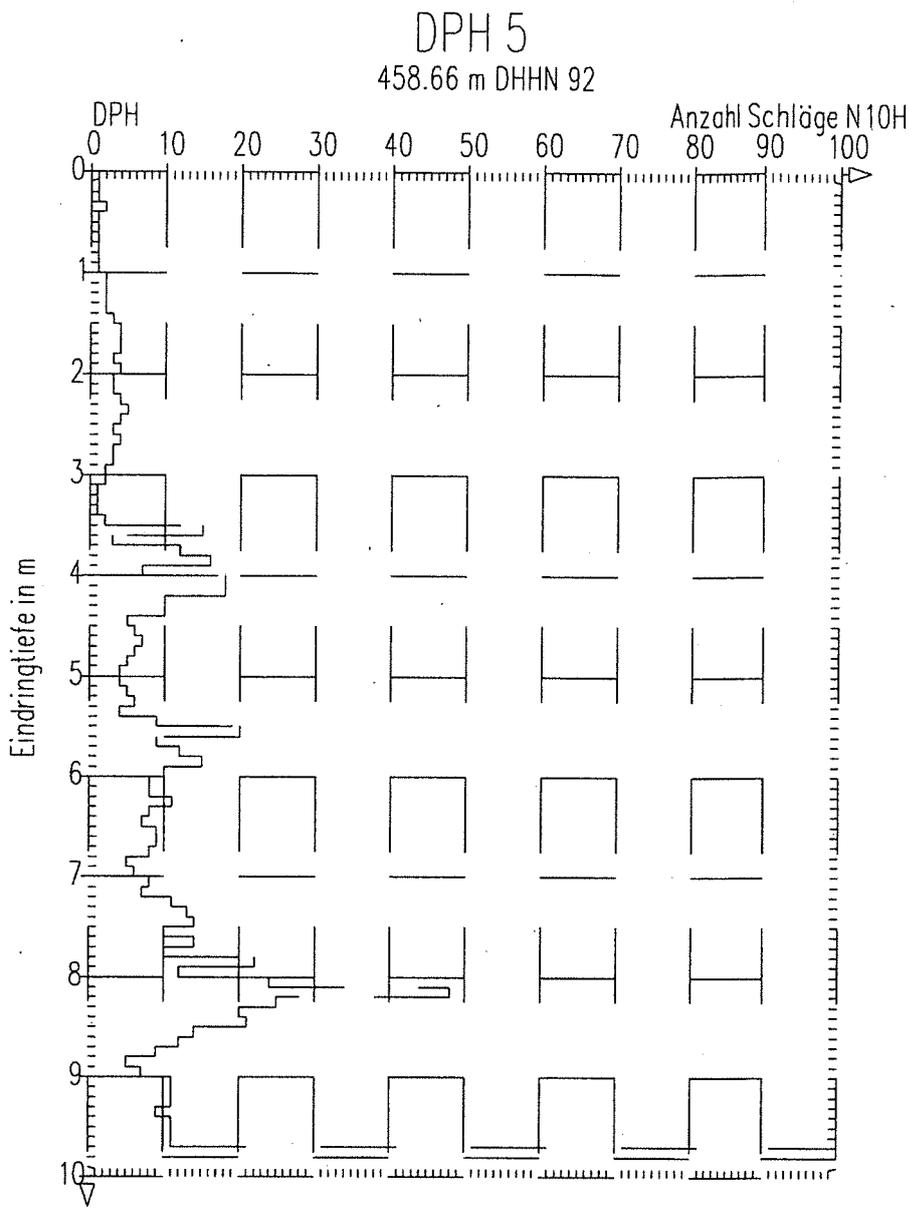


Terrasond GmbH & Co.KG	Projekt: B85 St 2166 BGU, Mönlas		
St.-Ulrich-Straße 12-16	ProjektNr.: 2019-1001	Datum:	05.11.2019
89312 Günzburg-Deffingen	Koordinaten: 4477043.80 / 5496101.12		
Tel.: 08221/906-0 / Fax: -40	Maßstab: 1:75	Ausgeführt von: Dominik Bergmann	

Tiefe	No	Tiefe	No
0.10	0	6.10	8
0.20	0	6.20	8
0.30	109	6.30	9
0.40	107	6.40	10
0.50	36	6.50	10
0.60	8	6.60	10
0.70	4	6.70	9
0.80	2	6.80	20
0.90	3	6.90	18
1.00	1	7.00	11
1.10	2	7.10	12
1.20	1	7.20	12
1.30	1	7.30	11
1.40	1	7.40	12
1.50	1	7.50	11
1.60	0	7.60	12
1.70	1	7.70	13
1.80	2	7.80	16
1.90	2	7.90	13
2.00	4	8.00	13
2.10	2	8.10	13
2.20	7	8.20	14
2.30	13	8.30	15
2.40	7	8.40	21
2.50	7	8.50	16
2.60	3	8.60	15
2.70	2	8.70	14
2.80	1	8.80	15
2.90	3	8.90	17
3.00	4	9.00	20
3.10	5	9.10	17
3.20	4	9.20	26
3.30	4	9.30	17
3.40	4	9.40	18
3.50	4	9.50	26
3.60	3	9.60	20
3.70	3	9.70	18
3.80	2	9.80	24
3.90	3	9.90	20
4.00	4	10.00	14
4.10	4	10.10	13
4.20	3	10.20	28
4.30	4	10.30	23
4.40	4	10.40	25
4.50	5	10.50	23
4.60	5	10.60	22
4.70	5	10.70	100
4.80	4		
4.90	5		
5.00	5		
5.10	6		
5.20	5		
5.30	7		
5.40	6		
5.50	6		
5.60	7		
5.70	7		
5.80	9		
5.90	8		
6.00	8		

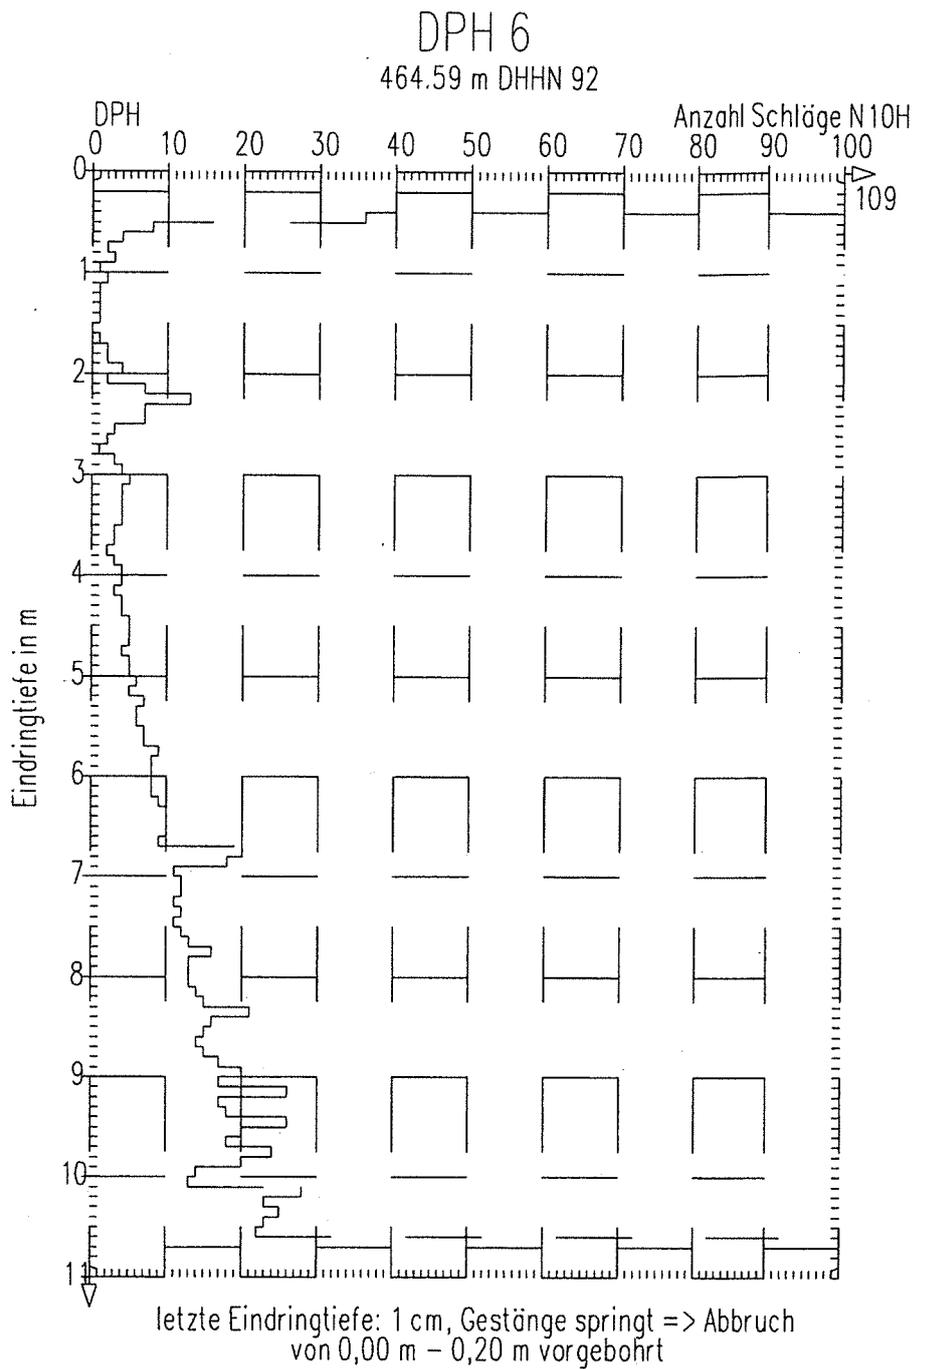


Tiefe	Nio	Tiefe	Nio
0.10	0	6.10	5
0.20	0	6.20	4
0.30	0	6.30	6
0.40	0	6.40	5
0.50	0	6.50	6
0.60	0	6.60	6
0.70	0	6.70	6
0.80	0	6.80	7
0.90	0	6.90	6
1.00	1	7.00	5
1.10	0	7.10	5
1.20	0	7.20	6
1.30	0	7.30	5
1.40	0	7.40	6
1.50	0	7.50	6
1.60	5	7.60	7
1.70	7	7.70	10
1.80	9	7.80	8
1.90	6	7.90	5
2.00	12	8.00	7
2.10	8	8.10	54
2.20	8	8.20	13
2.30	12	8.30	8
2.40	14	8.40	7
2.50	14	8.50	6
2.60	15	8.60	6
2.70	16	8.70	9
2.80	11	8.80	100
2.90	10		
3.00	11		
3.10	12		
3.20	10		
3.30	10		
3.40	8		
3.50	6		
3.60	5		
3.70	4		
3.80	5		
3.90	4		
4.00	4		
4.10	5		
4.20	4		
4.30	3		
4.40	4		
4.50	5		
4.60	5		
4.70	4		
4.80	4		
4.90	4		
5.00	5		
5.10	6		
5.20	3		
5.30	4		
5.40	8		
5.50	3		
5.60	3		
5.70	3		
5.80	5		
5.90	4		
6.00	4		

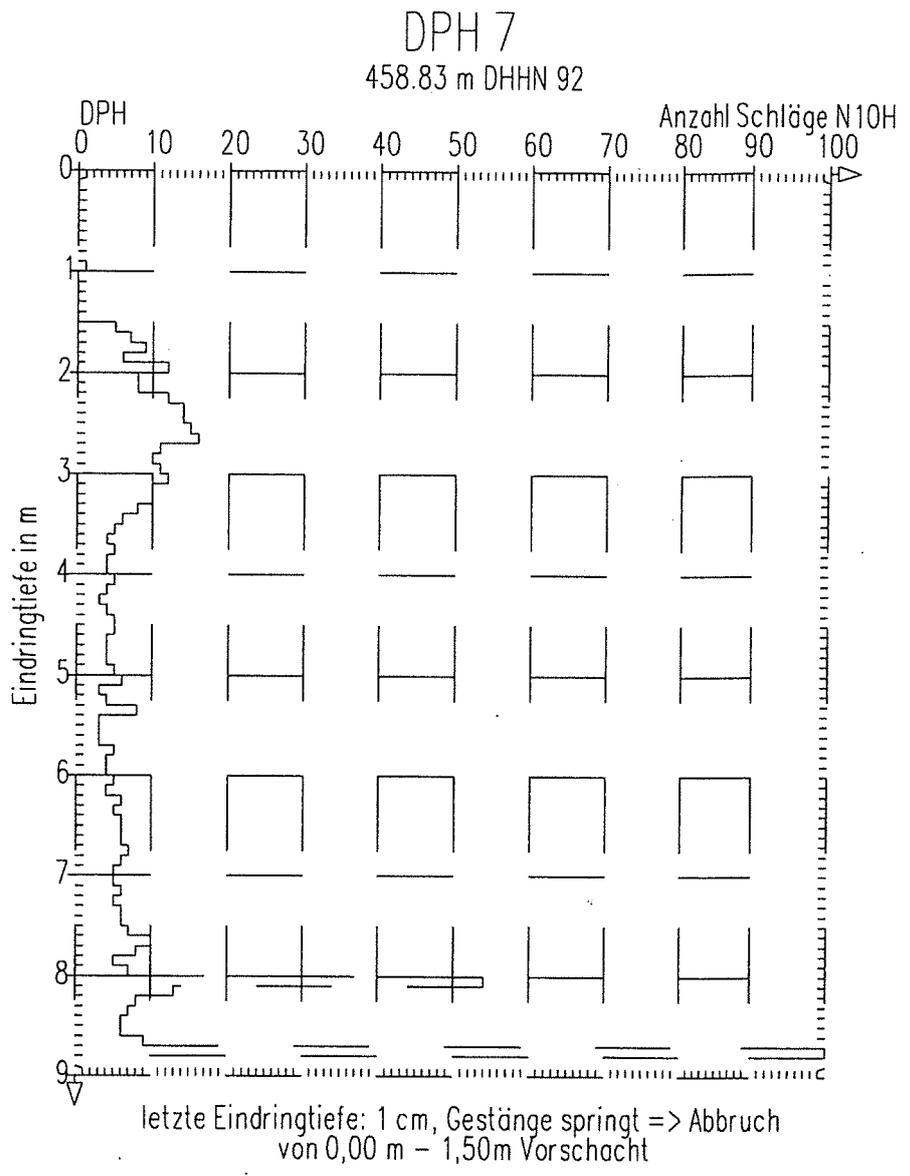

Terrasond GmbH & Co.KG	Projekt: B85 St 2166 BGU, Mönlas		
St.-Ulrich-Straße 12-16	ProjektNr.: 2019-1001	Datum:	14.11.2019
89312 Günzburg-Deffingen	Koordinaten: 4477063.54 / 5496076.36		
Tel.: 08221/906-0 / Fax: -40	Maßstab: 1:75	Ausgeführt von: Dominik Bergmann	

Tiefe	Nio	Tiefe	Nio
0.10	0	6.10	4
0.20	0	6.20	3
0.30	89	6.30	2
0.40	65	6.40	2
0.50	68	6.50	3
0.60	53	6.60	3
0.70	17	6.70	2
0.80	3	6.80	2
0.90	2	6.90	3
1.00	2	7.00	2
1.10	1	7.10	2
1.20	1	7.20	2
1.30	1	7.30	2
1.40	1	7.40	2
1.50	1	7.50	2
1.60	1	7.60	3
1.70	1	7.70	4
1.80	1	7.80	3
1.90	2	7.90	4
2.00	2	8.00	5
2.10	2	8.10	5
2.20	2	8.20	4
2.30	3	8.30	3
2.40	2	8.40	4
2.50	5	8.50	5
2.60	5	8.60	4
2.70	2	8.70	4
2.80	1	8.80	6
2.90	2	8.90	4
3.00	1	9.00	5
3.10	2	9.10	4
3.20	2	9.20	5
3.30	1	9.30	5
3.40	1	9.40	4
3.50	1	9.50	5
3.60	1	9.60	5
3.70	0	9.70	5
3.80	1	9.80	4
3.90	2	9.90	4
4.00	2	10.00	4
4.10	5	10.10	5
4.20	2	10.20	4
4.30	1	10.30	4
4.40	3	10.40	5
4.50	2	10.50	5
4.60	1	10.60	4
4.70	2	10.70	5
4.80	2	10.80	3
4.90	2	10.90	4
5.00	2	11.00	4
5.10	3	11.10	4
5.20	1	11.20	3
5.30	2	11.30	5
5.40	2	11.40	4
5.50	2	11.50	4
5.60	2	11.60	8
5.70	2	11.70	73
5.80	1	11.80	100
5.90	2		
6.00	2		

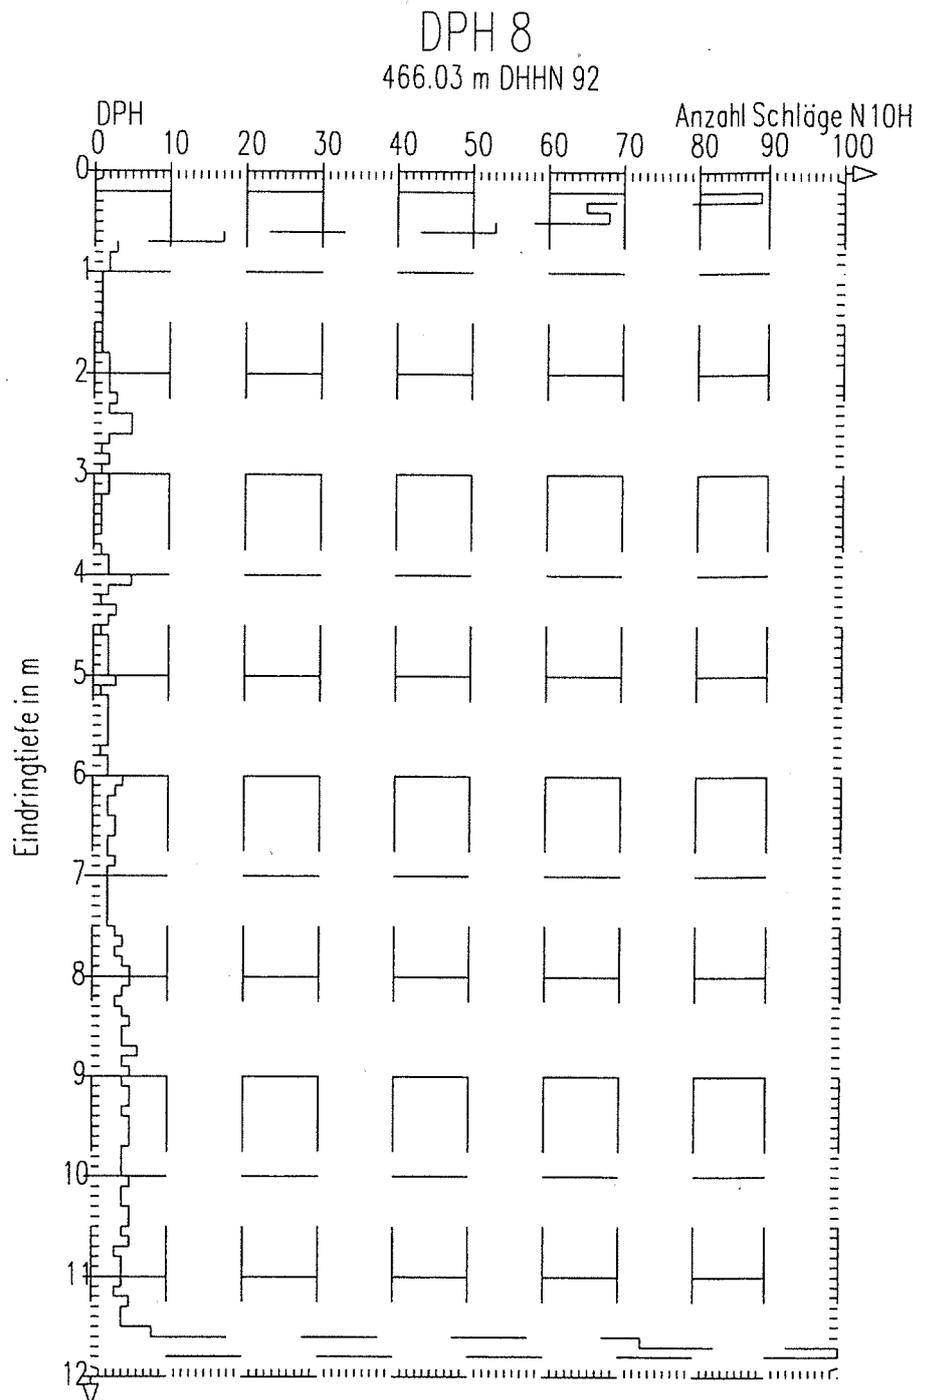

letzte Eindringtiefe: 2 cm, Gestänge springt => Abbruch  
von 0,00 m bis 0,20 m vorgebohrt